
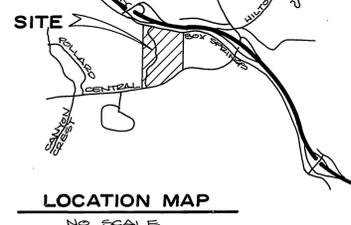
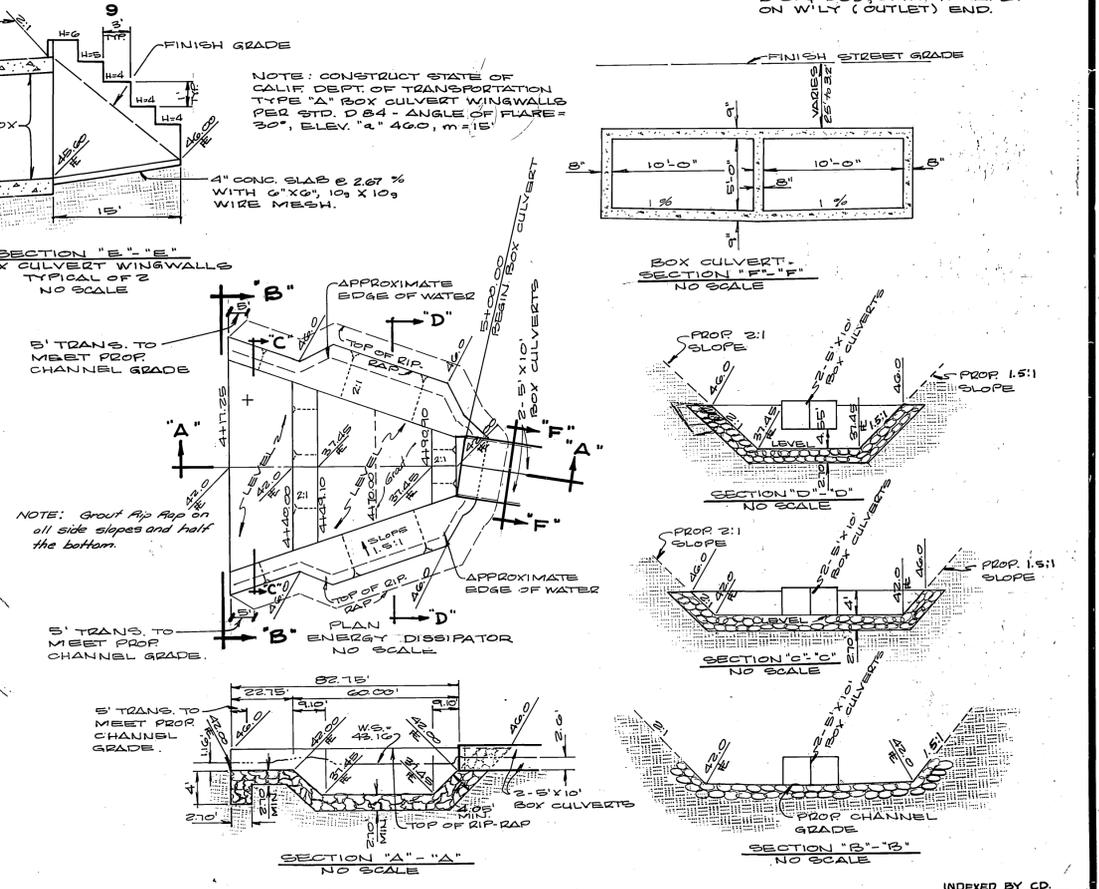


- GENERAL NOTES:**
1. It shall be the responsibility of the contractor to clear the right of way in accordance with the provisions of law as it affects each utility including irrigation lines and appurtenances and at no cost to the City.
 2. Construction shall be in accordance with the City of Riverside, Dept. of Public Works, Std. Dwg. 5th Dwg No. 10 and the Std. Specifications for Public Works Construction, current edition.
 3. The private engineer signing these plans is responsible for assuring the accuracy and acceptability of the work hereon. In the event of discrepancies arising during construction, the private engineer shall be responsible for determining an acceptable solution and revising the plans for approval by the City.
 4. The developer shall be responsible for preserving or re-establishing and referencing survey monuments destroyed, disturbed or buried as a result of construction shown hereon.
 5. All flagged elevations shall be staked in the field by the private engineer.
 6. The contractor shall call in a location request to Underground Service Alert (USA), Phone No. 1-800-422-4133, two working days prior to digging. No construction permit will be issued by the Public Works Dept. involving excavation for underground facilities unless the applicant has been provided an inquiry identification number by U.S.A.
 7. Before the rip rap is accepted, as placed, at the outlet of any drainage structure, it shall be tested under flows as close as possible to design conditions with water obtained from fire hydrants in the immediate area.

NOTE: CONSTRUCT STATE OF CALIF. DEPT. OF TRANSPORTATION DOUBLE BOX CULVERT STD. NO. D 81 & D 82, OMIT PARAPET ON W'LY (OUTLET) END.

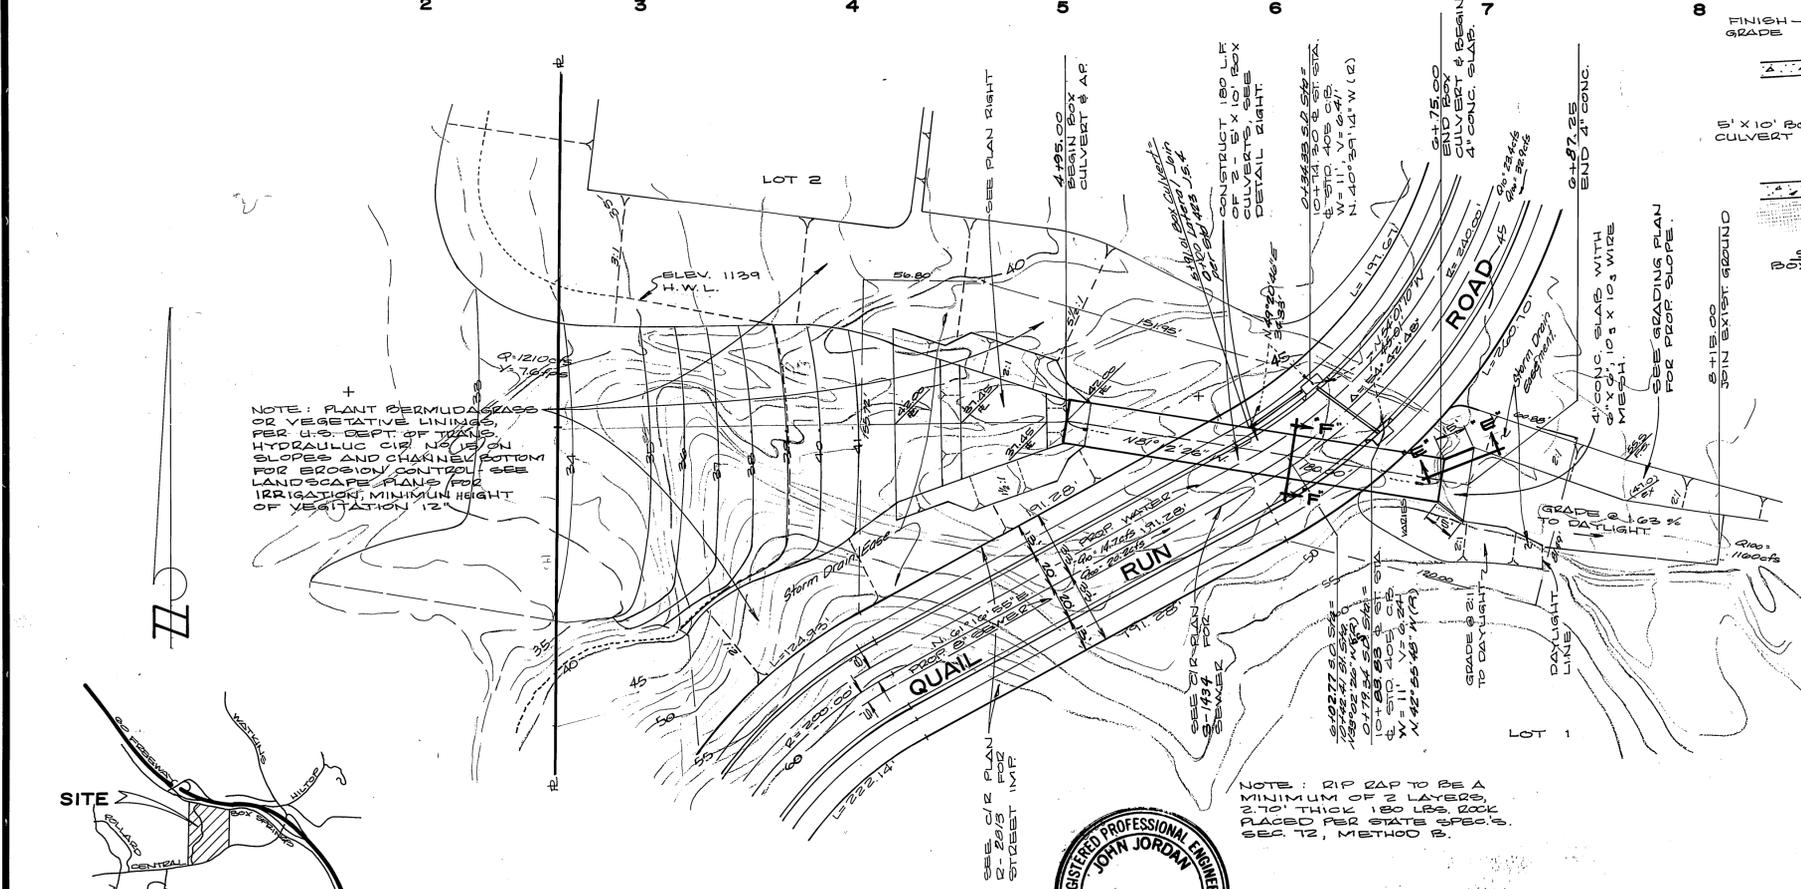

NOTE: PLANT BERMUDA GRASS OR VEGETATIVE LININGS, PER U.S. DEPT. OF TRANSPORTATION HYDRAULIC CIR. NO. 10 ON SLOPES AND CHANNEL BOTTOM FOR EROSION CONTROL. SEE LANDSCAPE PLANS FOR IRRIGATION, MINIMUM HEIGHT OF VEGETATION 12"

NOTE: RIP RAP TO BE A MINIMUM OF 2 LAYERS, 2" TO 4" THICK 180 LBS. ROCK PLACED PER STATE STD. SEC. 12, METHOD B.



ALBERT A. WEBB ASSOCIATES CIVIL ENGINEERS RIVERSIDE, CALIFORNIA (951) 516-1010		CITY OF RIVERSIDE, CALIFORNIA PUBLIC WORKS DEPARTMENT		TRACT NO. 14540 STORM DRAIN PLAN & PROFILE QUAIL RUN ROAD		INDEXED BY CD. ACCOUNT No. DRAWING NUMBER D-498 SHEET 1 OF 1	
APPROVED BY: <i>[Signature]</i> DATE: 4-15-87 R.E. No. 27983		APPROVED BY: <i>[Signature]</i> DATE: 4-15-87 DIRECTOR OF PUBLIC WORKS		SCALE: HORZ. 1"=40', VERT. 1"=8'		83-44-D	
W.O. 83-44 FOR GUARANTY SERVICE CORP. 10/1/85 DESIGNED BY: [Signature] DRAWN BY: [Signature] CHECKED BY: [Signature]		REVISIONS: [Table with columns for MARK, REVISIONS, APPR., DATE]		DATE: 3-16-87			